

ADDITIONS AND RENOVATIONS TO THE PAN-AM POOL WINNIPEG MANITOBA

PAN AMERICAN GAMES SOCIETY (WPG 1999)
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DRAWING LIST

ARCHITECTURAL

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- A2.1 BASEMENT PLAN
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- A2.3 UPPER LOBBY PLAN
- A3.1 WEST ELEVATION, NORTH ELEVATION
- A4.1 SOUTH ELEVATION, BUILDING SECTION
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- A6.3 REFLECTED CEILING PLAN - EAST
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STRUCTURAL

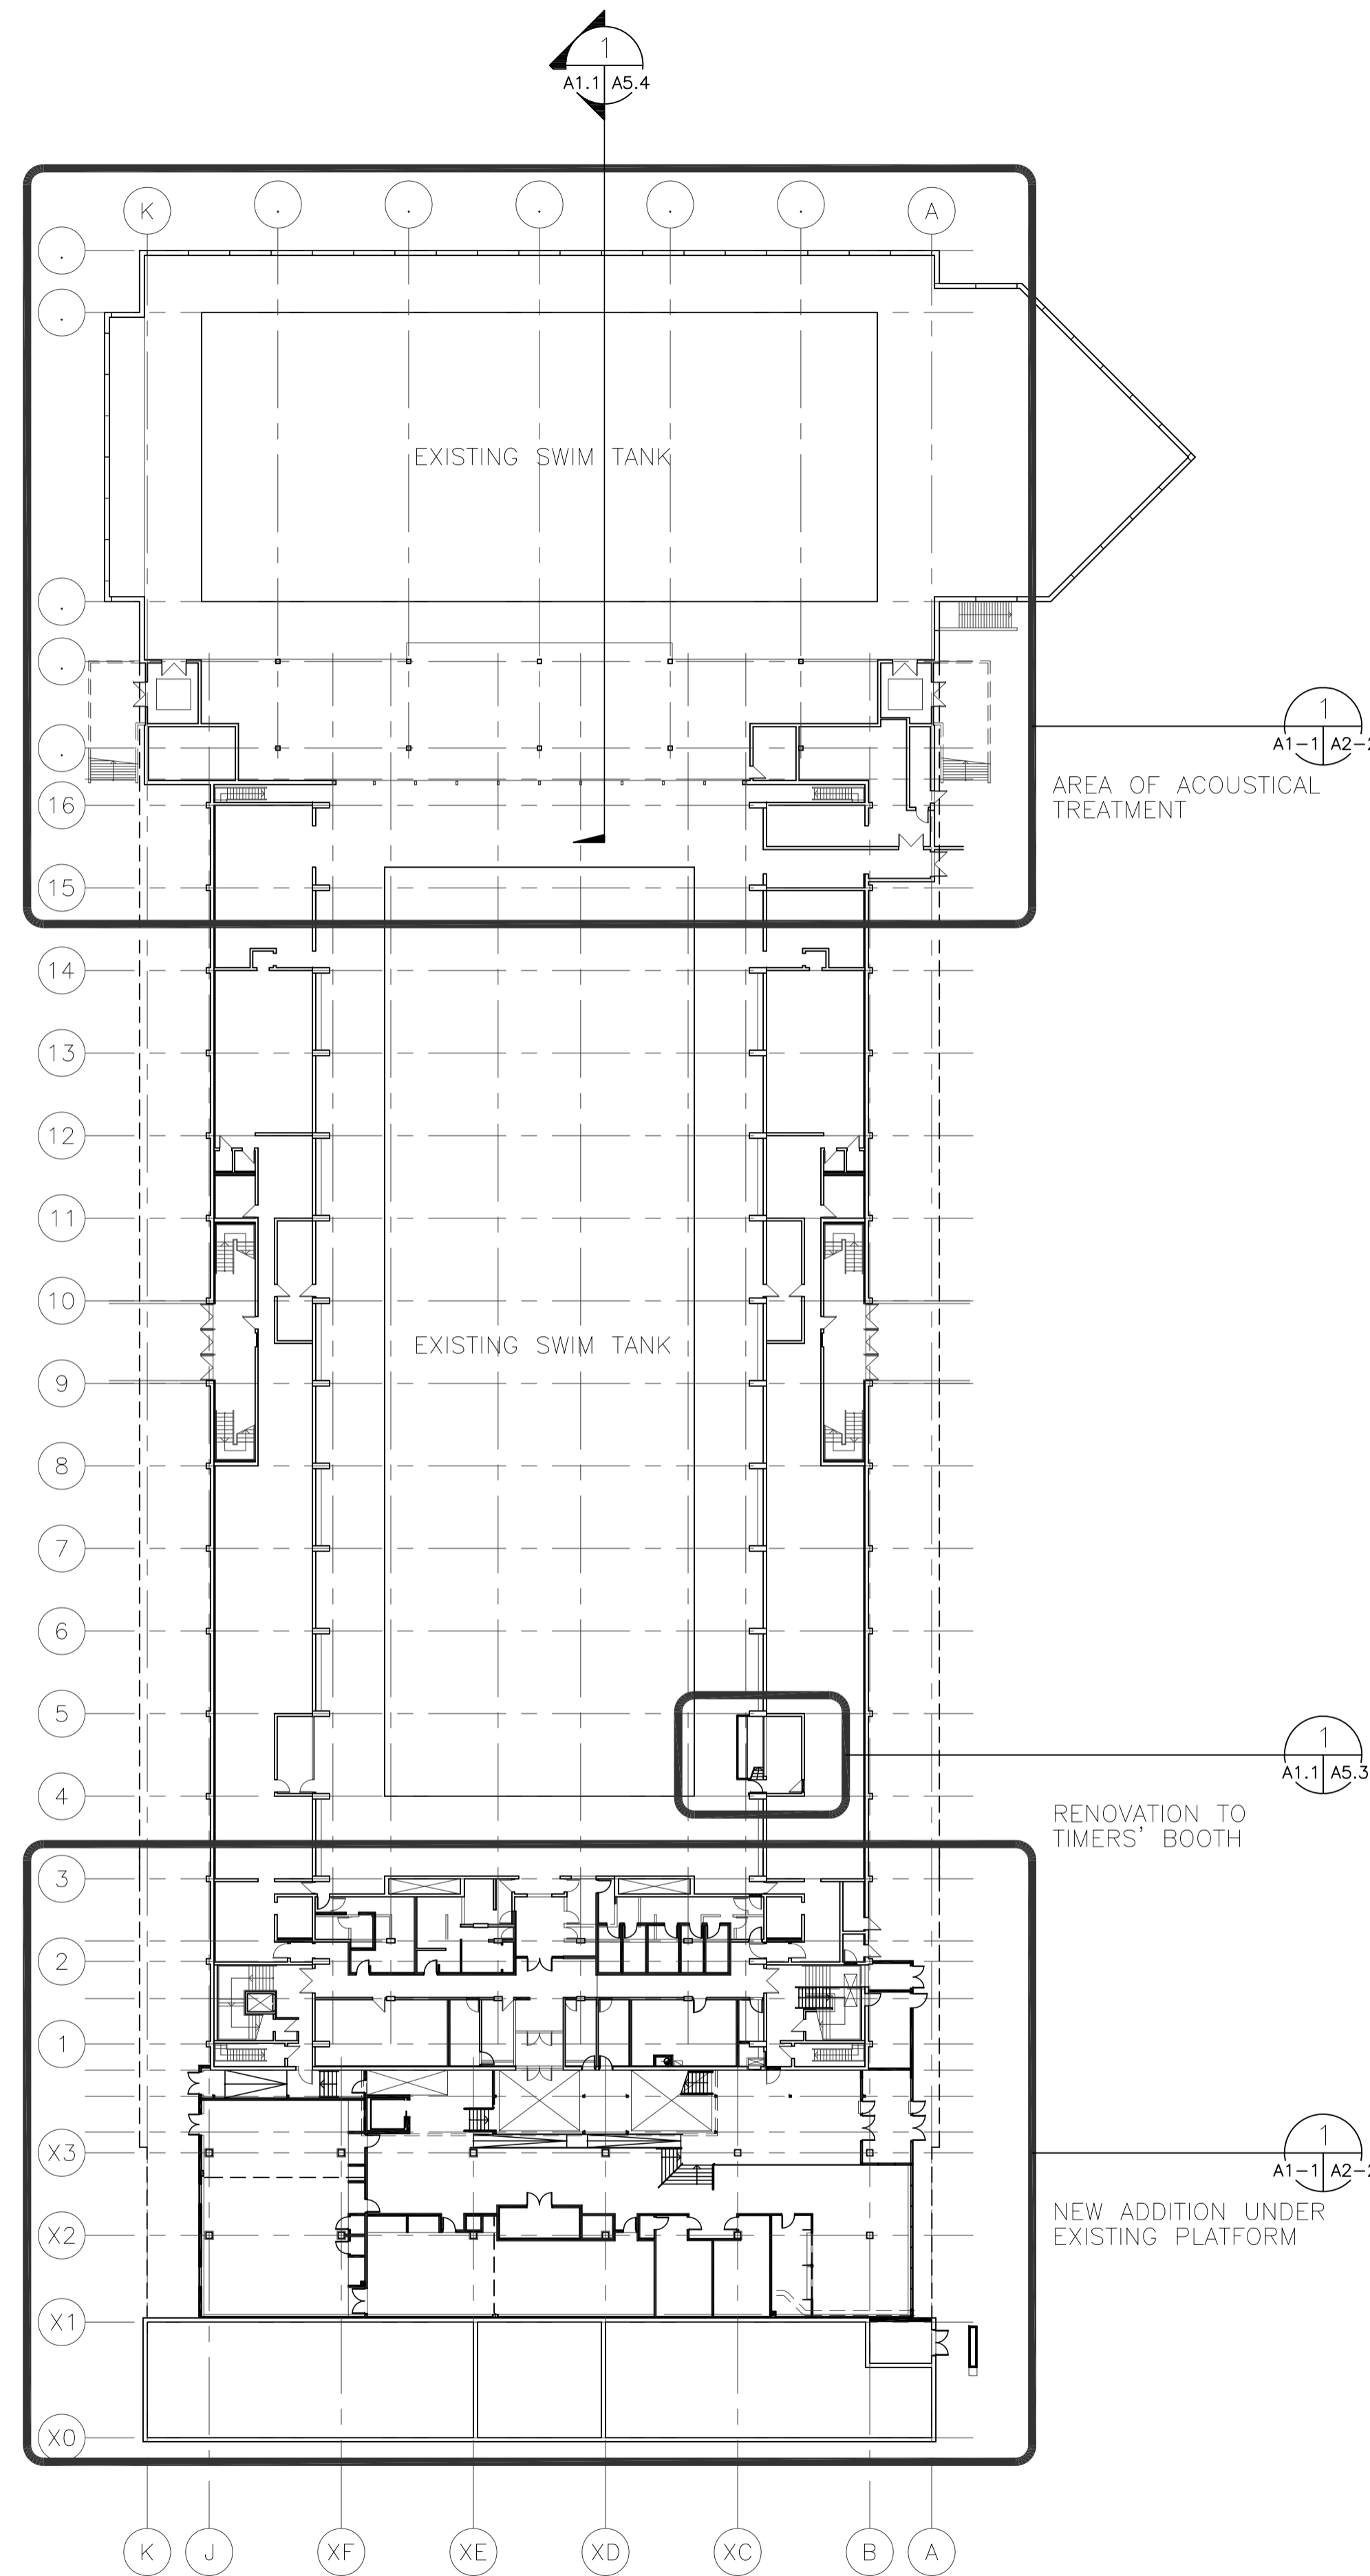
- S2.1 FOUNDATION AND MAIN FLOOR FRAMING PLANS
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ELECTRICAL

- EP2.2 PARTIAL MAIN FLOOR PLAN POWER AND SYSTEMS
- E2.1 BASEMENT PLAN - ELECTRICAL & MOTOR SCHEDULE
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- EL2.2 PARTIAL FLOOR PLAN LIGHTING



1 KEY PLAN - POOL LEVEL
0 20 40 60 80 100 1" = 30'

WALL TYPES	ROOF TYPES
<p>W1 1/2" G.W.B. (+1/2" CEMENT BOARD) 1/2" G.W.B. 3 5/8" STEEL STUDS @ 16" O/C BATT INSULATION 1/2" G.W.B. (+1/2" CEMENT BOARD) NOTE: SIDE WITH DOUBLE LAYER TO BE LAMINATED, VERTICAL JOINTS STAGGERED.</p> <p>(*) CEMENT BOARD UDER CERAMIC TILES</p> <p>W2 2 LAYERS 1/2" TYPE X G.W.B. 3 5/8" STEEL STUDS @ 16" O/C BATT INSULATION 2 LAYERS 1/2" TYPE X G.W.B.</p> <p>W3 8" CONCRETE BLOCK NOTE: PROVIDE MIXTURE OF TEXTURED AND COLOURED BLOCK FOR UPPER TWO LEVELS.</p> <p>W4 1/2" G.W.B. 3 5/8" STEEL STUDS @ 16" O/C 1/2" G.W.B.</p> <p>W5 1/2" G.W.B. 3 5/8" STEEL STUDS @ 16" O/C BATT INSULATION 1/2" G.W.B.</p> <p>W6 EXISTING CONCRETE 3 5/8" STEEL STUDS @ 24" O/C BATT INSULATION POLY V.B. 1/2" G.W.B.</p> <p>W7 PREFINISHED STEEL SIDING GALV. FURRING / GIRT SYSTEM 2" RIGID INSULATION BITUMINOUS AIR V.B. 1/2" BACKING BOARD 3 5/8" STEEL STUD @ 16" O/C BATT INSULATION 1/2" G.W.B.</p> <p>W8 1/2" G.W.B. 3 5/8" STEEL STUDS @ 16" O/C 1/2" WATER PROOF DRYWALL CEMENT BOARD</p> <p>W9 EXTERIOR ALUM. WINDOW SYSTEM NOTE: INSULATED SPANDREL PANELS AS INDICATED</p> <p>W10 INTERIOR ALUM. GLAZED SYSTEM</p> <p>W11 CEMENTOUS FINISH ON 1/2" CEMENT BOARD BACKING 2" RIGID INSULATION BITUMINOUS AIR V.B. 8" CONCRETE 2 1/2" STEEL STUD BATT INSULATION 1/2" G.W.B.</p> <p>W12 PREFINISHED ALUMINUM FLASHING ROOFING MEMBRANE 1/2" PLYWOOD 6" STEEL STUD @ 16" O/C BATT INSULATION POLY V.B. 1/2" G.W.B. NOTE: STRUCTURAL REINFORCING AS REQUIRED.</p> <p>W13 1/2" G.W.B. CONTINUOUS POLY V.B. 2 1/2" STEEL STUD BATT INSULATION 8" REINFORCED CONCRETE 2" RIGID INSULATION</p> <p>W14 EXISTING WALL 2 1/2" STEEL STUD 1/2" G.W.B.</p> <p>W15 EXISTING 8" CONC. BLOCK WALL</p> <p>W16 EXISTING REINFORCED CONCRETE NOTE: PATCH FURRING AND PLASTER AS REQUIRED.</p>	<p>R1 PAVERS EPDM OR 4-PLY B.U.R. 2 1/2" RIGID POLYISO INSULATION VAPOUR BARRIER EXISTING CONCRETE</p> <p>R2 EPDM OR 4-PLY B.U.R. 2 1/2" RIGID POLYISO INSULATION VAPOUR BARRIER 1/2" G.W.B. 1 1/2" STEEL DECK STRUCTURAL STEEL SEE STRUCTURAL</p>

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Revisions/Issuance (Read Up)				
Initialed By				
Designed By	AC			
Drawn By	PPB			
Checked By	AC			
Approved By	JW			

Man-Shield
CONSTRUCTION INC.
205-698 CORYDON AVE
WINNIPEG, MANITOBA
R3M 0V9
(204) 453-9177

Smith Carter Architects
and Engineers Incorporated
1601 Buffalo Place
Winnipeg, Manitoba
Canada, R3T 3K7
Tel. (204) 477-1260
Fax. (204) 477-6346

Smith Carter
Architects
Engineers
Planners
Interior Designers

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Scales	AS NOTED
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